The proposed Corvette Landing project is located within the Township of Esquimalt. Within the Esquimalt Harbour neighbourhood in immediate proximity to the Naval Base and the Dockyards the future Corvette Landing is situated at the corner of Admirals Road and Naden Way. We believe that it is a very significant urban development site. The site spans the length of the block of Naden Way along a green space towards Constance Avenue. The proposed building is, in accordance with the municipal land use zoning, planned to be a high-density residential construction. As the plan is today, it will offer 83 market affordable homes consisting of a broad range of types and floor plans ranging from 316sf 1BR/studios to 1281sf 3BR family homes. Designed as a highquality building, it will serve as an urban development catalyst for the community of Esquimalt. The new building will advance the creation of a vibrant, diverse and prosperous community, as a new paradigm, through its unique combination of affordability, livability and sustainability.

For Development Permit - Corvette Landing

ALL DIMENSIONS ARE IN SQM (unless otherwise specified)

FSR AREA

162.58

216.28

310.39

454.30

547.48

594.30

698.82

709.22

483.47

451.51

247.49

4,995

1,442 Regular 1,609 HC

1,223 Small

125

1,936

2.58

Total (incl. Vis.)

Visitors

4,274 Grand Total

Ground) 2

Parking Area and Count (sqm)

Total

(parking) -1

(parking) -2

(parking) -

Lockers and Bike Storage

Unit Storage

Plaza Bike Stalls

Lot Coverage area

Bike Stalls

Site Area

FSR

Total

CORVETTE LANDING - 669 Constance Ave (all dimension in sqm unless otherwise noted)

GROSS

RESIDENTIAL

AREA

137.87

185.99

247.12

351.82

509.3

614.18

668.7

784.75

796.18

546.83

509.67

276.11

5,629

WALKWAY

AREA

85.10

109.35

120.96

33.76 35.94

total

The building will be a certified Passiv Haus standard, one of the globally leading standards for sustainability and energy efficiency. The project is proposed to be built using engineered BC produced mass-timber technology, providing a low carbon footprint and highly durable construction. Built through off-site prefabrication, utilizing the most modern technologies, the project will not only minimize site construction-related noise, and traffic, it will ultimately reduce construction waste while substantially reducing the length of the construction time itself

The location provides excellent connectivity to public transit and shopping in walkable distance. It is expected that some future

tenants will work in close proximity, being able	(enclosed)	880	
to walk to work. The site is also located on	Lot Coverage (not		
both the commuter and recreational bicycle pathways, facilitating biking as a viable	including		
alternative to automotive transport.	walkways and		
and the determinant of the moport.	stairs)%	45.4%	
Please refer to the Architects Letter to Mayor	Walkways and		
and Council for the detailed project rationale.	Stairs Lot		
	Coverage	8.0%	
	Building Height (above Admirals) (m)		
	Building Height (above Grade) (m)		
	Vertical Circulation	n	
		per floor	# of floor:
	front	28	
	back	10	
	Overall total		
	W. II A		
	Wall Area	full wall	II1611
	total	634	half wall
	total	634	
	Sellable Area		
	(to mid wall)	5,312	
	(15 11111 11111)	0,012	
	Amenity	218	
	-		
	Mezzanine	1,007	
	Above Ground		
	Gross Area	7,064	
RECEIVED	Total Gross Area	10,115	
HEOLIVED /	Total Gloss Alca	10,110	
			Number o
9.4	MIX	Type of Home	A COMPANY TO SERVICE THE
1111 0 6 0010		studio	Homoo
JUL 2 4 2018		1 BR	
		1 BR + tech	
CORP OF TOWNSHIP		2 BR	
CORP. OF TOWNSHIP		3BR	
2	Total		
Sign of the same			
OF ESCUMALI SERVICE			





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LWPAC

Structural

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Graham Flinch
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Phone: 604 873 1181 x 251

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Phone: 604.659.4449

Civil Engineer

Landscape Architect

Geotechnical Engineer

Traffic

Electrical

Mechanical




CORVETTE ANDING

A00.02

Project Data +



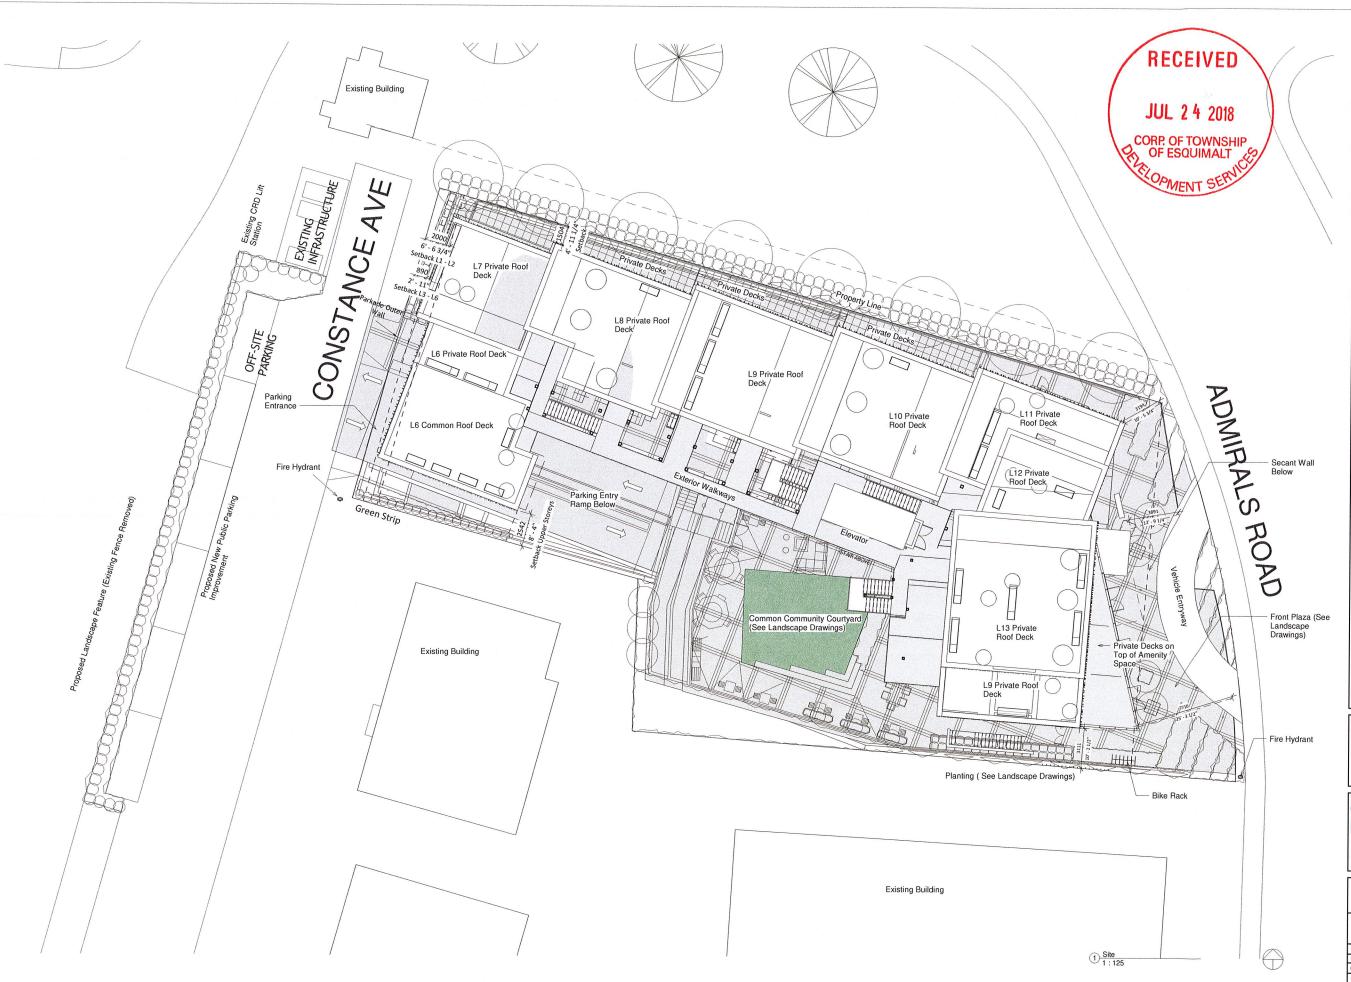

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Mechanical



CORVETTE LANDING


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Site Plan

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2018-07-24 ate: 4:02:25 AM	DWG#:
rawn: Author	
eviewed: OI	Revision:





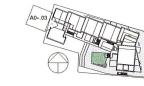

2 Site Keyplan - West 1:1000





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Mechanical



CORVETTE LANDING


699 Constance Avenue, Corsta 658, 660, 622 Admirals Road. Esquimalt (BC), V9A 6N9 Legal Lot Description: P.I.D. 004574451

A04.03

West Elevation

Scale: As indicated	File: CL_DD
Date: 2018-07-24 4:04:22 AM	DWG#:
Drawn: Author	
Reviewed: OL	Revision:

1 : 100

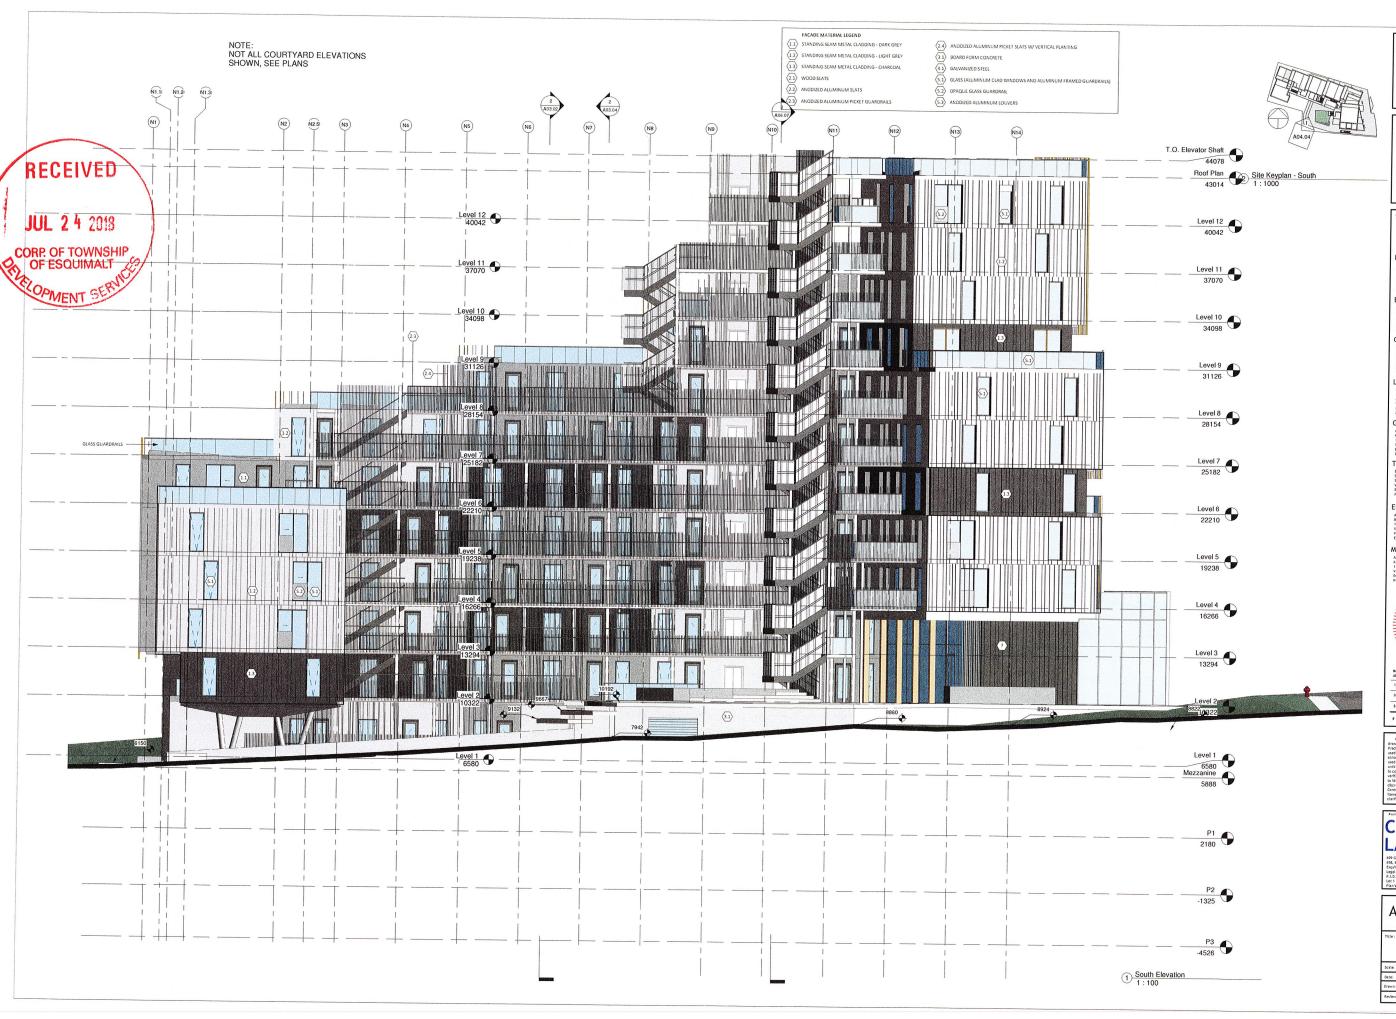

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Mechanical

del JUL 2 3 2018

10 Jul 24, 2018 - DEVELORMENT PERMIT
APPLICATION
9 Jan 31, 2018 - REZONING APPLICATION
8 Dec 22, 2017 - REZONING APPLICATION
6 - ADDITIONAL MATERIL
6 - ADDITIONAL MATERIL

CORVETTE LANDING

A04.04

South Flevation